

GENERAL NOTE:
COORDINATE THE STRUCTURAL AND MECHANICAL DRAWINGS WITH SIZE AND LOCATIONS OF ALL OPENINGS AND LOCATIONS OF ALL CONDUITS SHALL BE REVIEWED TO THE APPLICABLE CODES AND SPECIFICATIONS BEFORE PROCEEDING WITH THE WORK.



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S O O R A
A R C H I
T E C T S


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CITY OF MESA
MESA ARTS CENTER
PLW SET
A


DATE: 01/24/02
DRAWN BY: TRR
CHECKED BY: TRR
SCALE: 1/8"=1'-0"
PROJECT NO: 02044731
SHEET NO: A43

BID SET
BUILDING SECTION
REPERTORY CENTER

SCALE: 1/8"=1'-0"
DRAWN BY: TRR
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DATE: January 29, 2002
SHEET NUMBER: A43

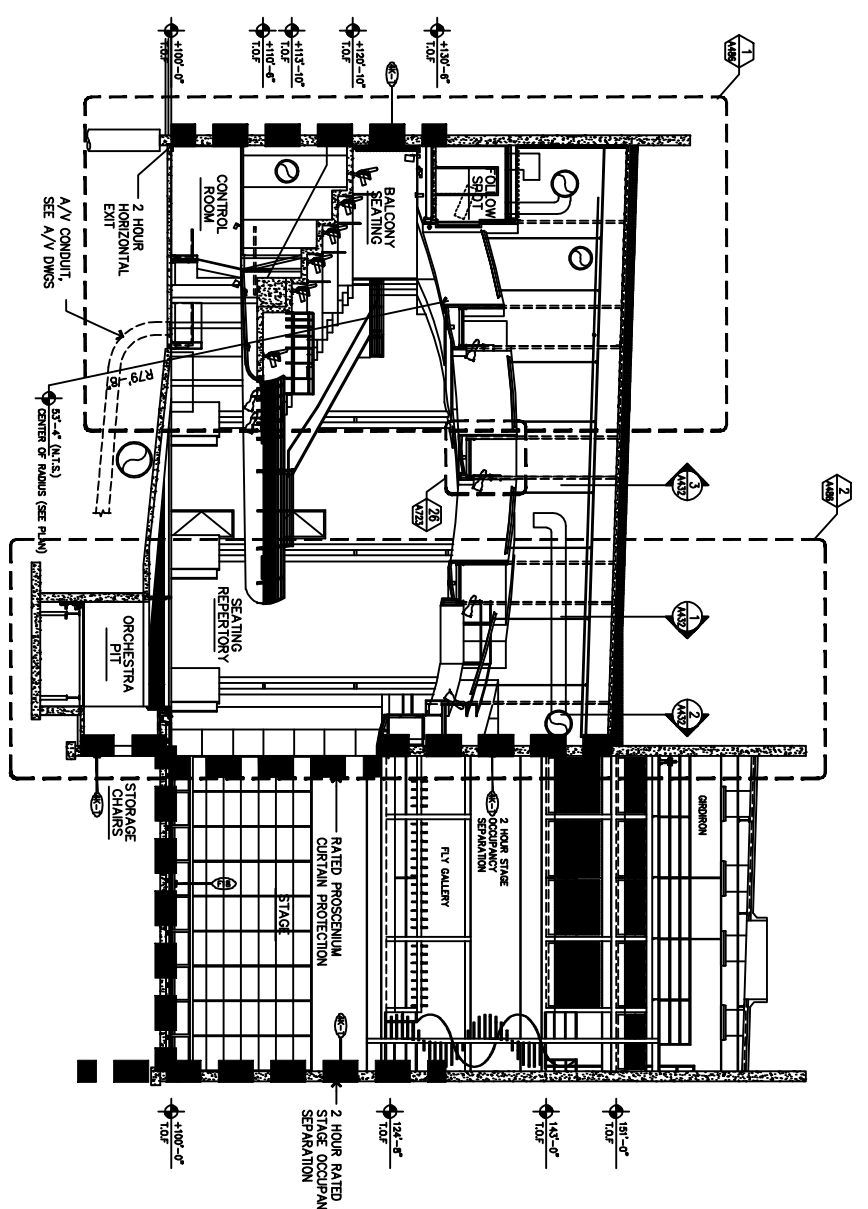

1 EAST - WEST LONGITUDINAL SECTION @ CENTER OF AUDITORIUM
1/8" = 1'-0"

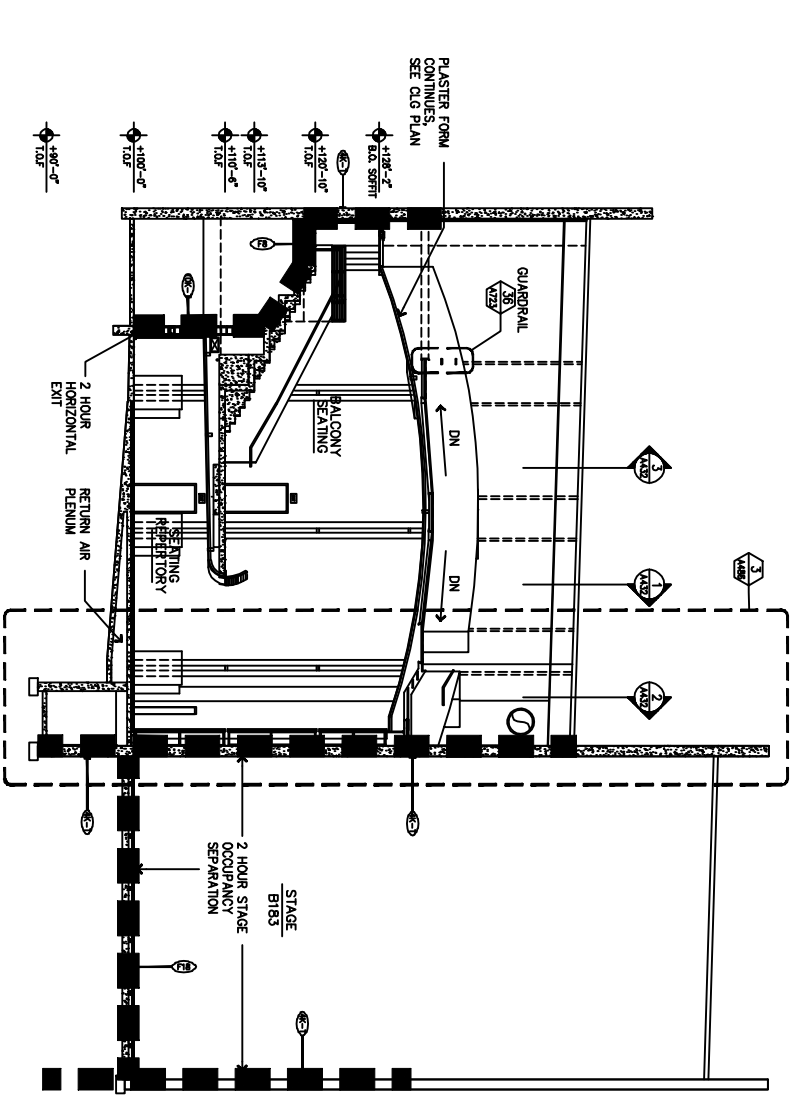

2 EAST - WEST LONGITUDINAL SECTION THROUGH CATWALK
1/8" = 1'-0"



- GENERAL NOTES:**
1. ALL DIMENSIONS SHOWN ARE TO FACE OF FINISH UNLESS OTHERWISE NOTED.
 2. CONCRETE SHALL BE REINFORCED AND CAST FITTINGS OR EMBEDMENTS SHALL BE REINFORCED AND CAST IN PLACE.
 3. CONCRETE TO BE CAST WITH BRACKED REINFORCEMENT FOR WALLS AND FLOORS.
 4. PROVIDE ONE (1) IN. BARRING AND TIE BARRING AS SHOWN TO SUPPORT WALL, CEILING AND CABINETS. GRADE BARS, REINFORCING BARS AND ALL OTHER WALL REINFORCING SHALL BE INSTALLED PRIOR TO INSTALLATION OF CONCRETE BOARD OR OTHER WALL FINISH. COORDINATED REQUIREMENTS FOR REINFORCED METAL STUD DOORS.
 5. PROVIDE REINFORCING STEEL POSTS AS REQUIRED FOR ALL FREE STANDING PARTIAL-WALL WALLS.
 6. ALL DRYPWALL AND METAL STUD SOFFIT AND CEILING FINISHING AND CONNECTIONS TO STRUCTURE TO BE DESIGN BUILT.
 7. PROVIDE METAL STUD OR MISCELLANEOUS STEEL DIAGONAL BRACING AS REQUIRED AT SOFFIT, OVER, PARTITIONS AND OTHER ASSEMBLIES WHETHER OR NOT INDICATED ON DRAWINGS.
 8. ALL FOUNDATIONS ARE APPROXIMATE AND SHOWN FOR INFORMATION ONLY. CONSULT ENGINEERING FOR STRUCTURAL DRAWINGS.
 9. SECTIONS AND WALL SECTIONS ARE DIAGNOSTIC. SEE STRUCTURAL DRAWINGS FOR ADDITIONAL INFORMATION ON FOUNDATIONS, WALLS, PARTITIONS, AND ALL OTHER FINISHES. SEE CODE PLANS AND SPECIFICATIONS FOR ADDITIONAL INFORMATION ON FOUNDATIONS.
 10. ALL CEILING AND SEALANTS ARE TO MATCH COLOR OF WALLS.
 11. ALL EXTERIOR WALLS TO HAVE THERMAL INSULATION AS SHOWN IN THE PROJECT MANUAL, VOL. 1.

SEE EXISTENCE NOTE:
MANY HAVE FIRE RESISTIVE SYSTEMS ARE USED THROUGHOUT CODE AND OCCUPANCY AS SHOWN ON THE DRAWINGS. SEE ADDITIONAL FIRE RESISTIVE INFORMATION FOR WALL TYPES AND OCCUPANCY AS SHOWN ON THE DRAWINGS. SEE PLANS FOR SYSTEM LOCATIONS.